




1 PARTIAL FOUNDATION PLAN
S100
SCALE AT FULL SIZE 1/4" = 1'-0"

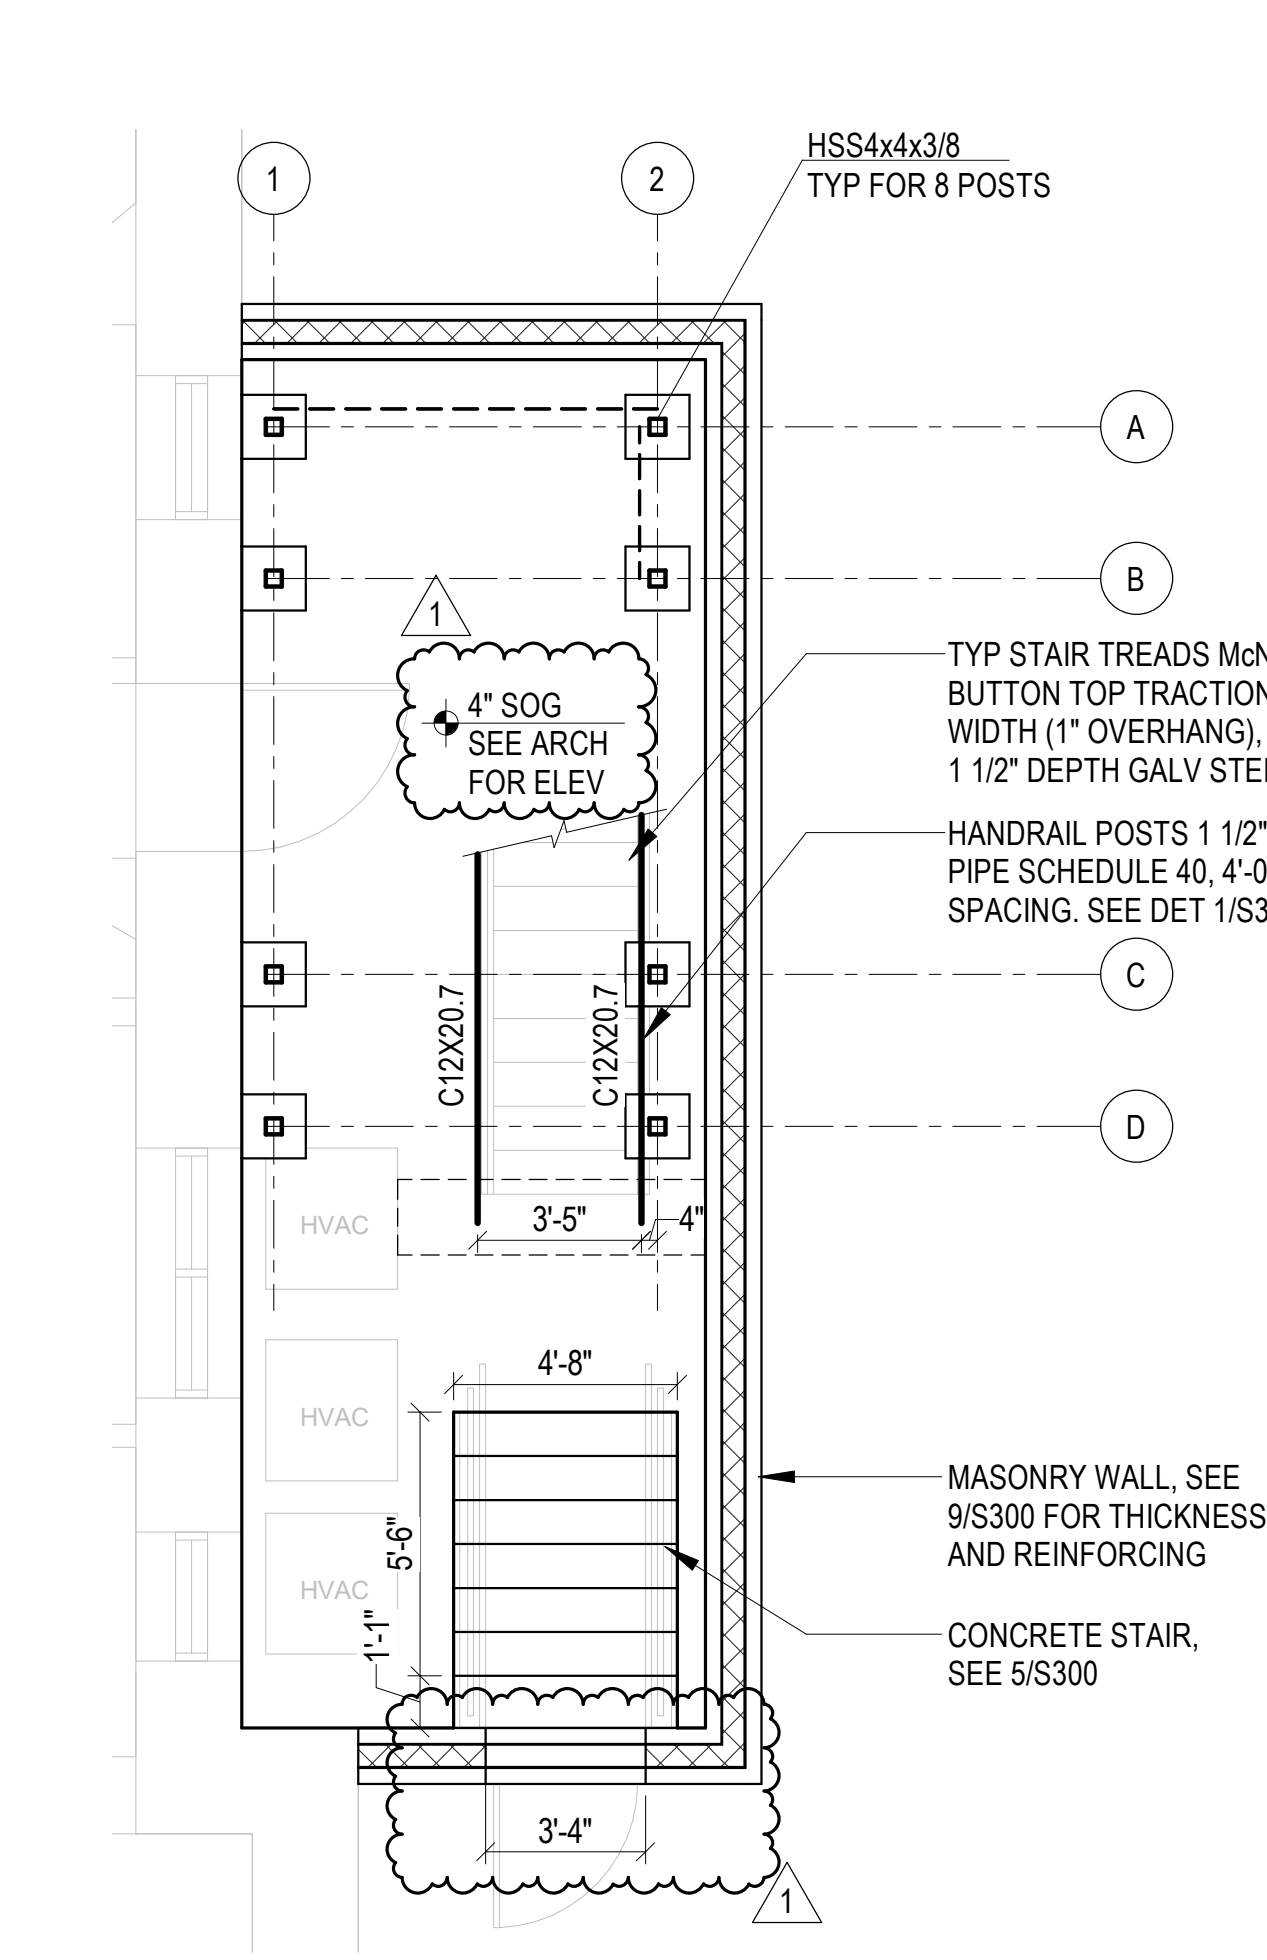


2 PARTIAL BASEMENT PLAN
S100
SCALE AT FULL SIZE 1/4" = 1'-0"

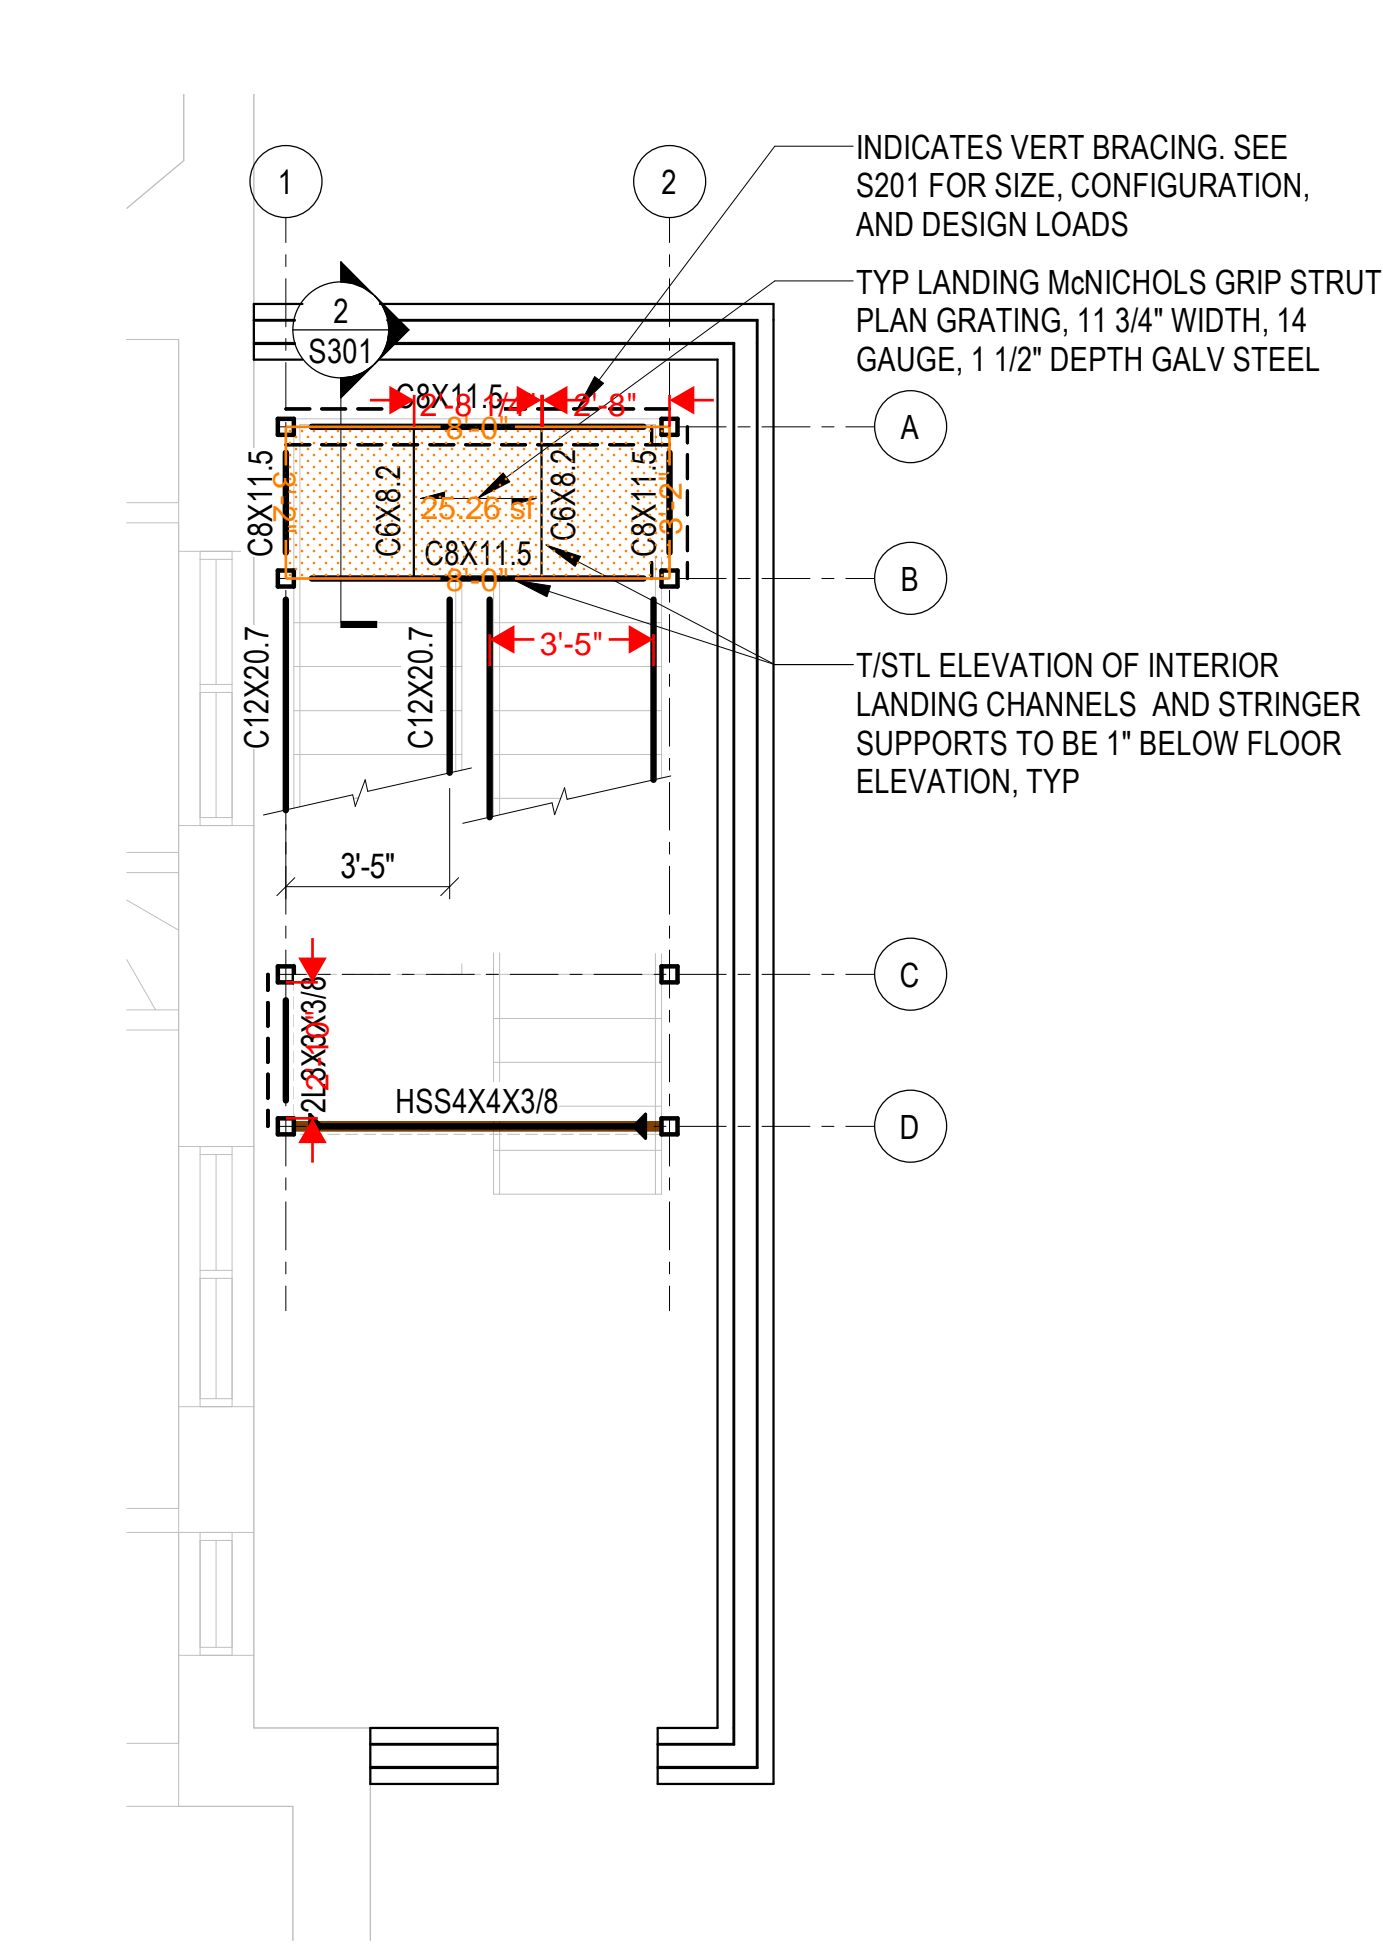

3 PARTIAL FIRST FLOOR PLAN
S100
SCALE AT FULL SIZE 1/4" = 1'-0"

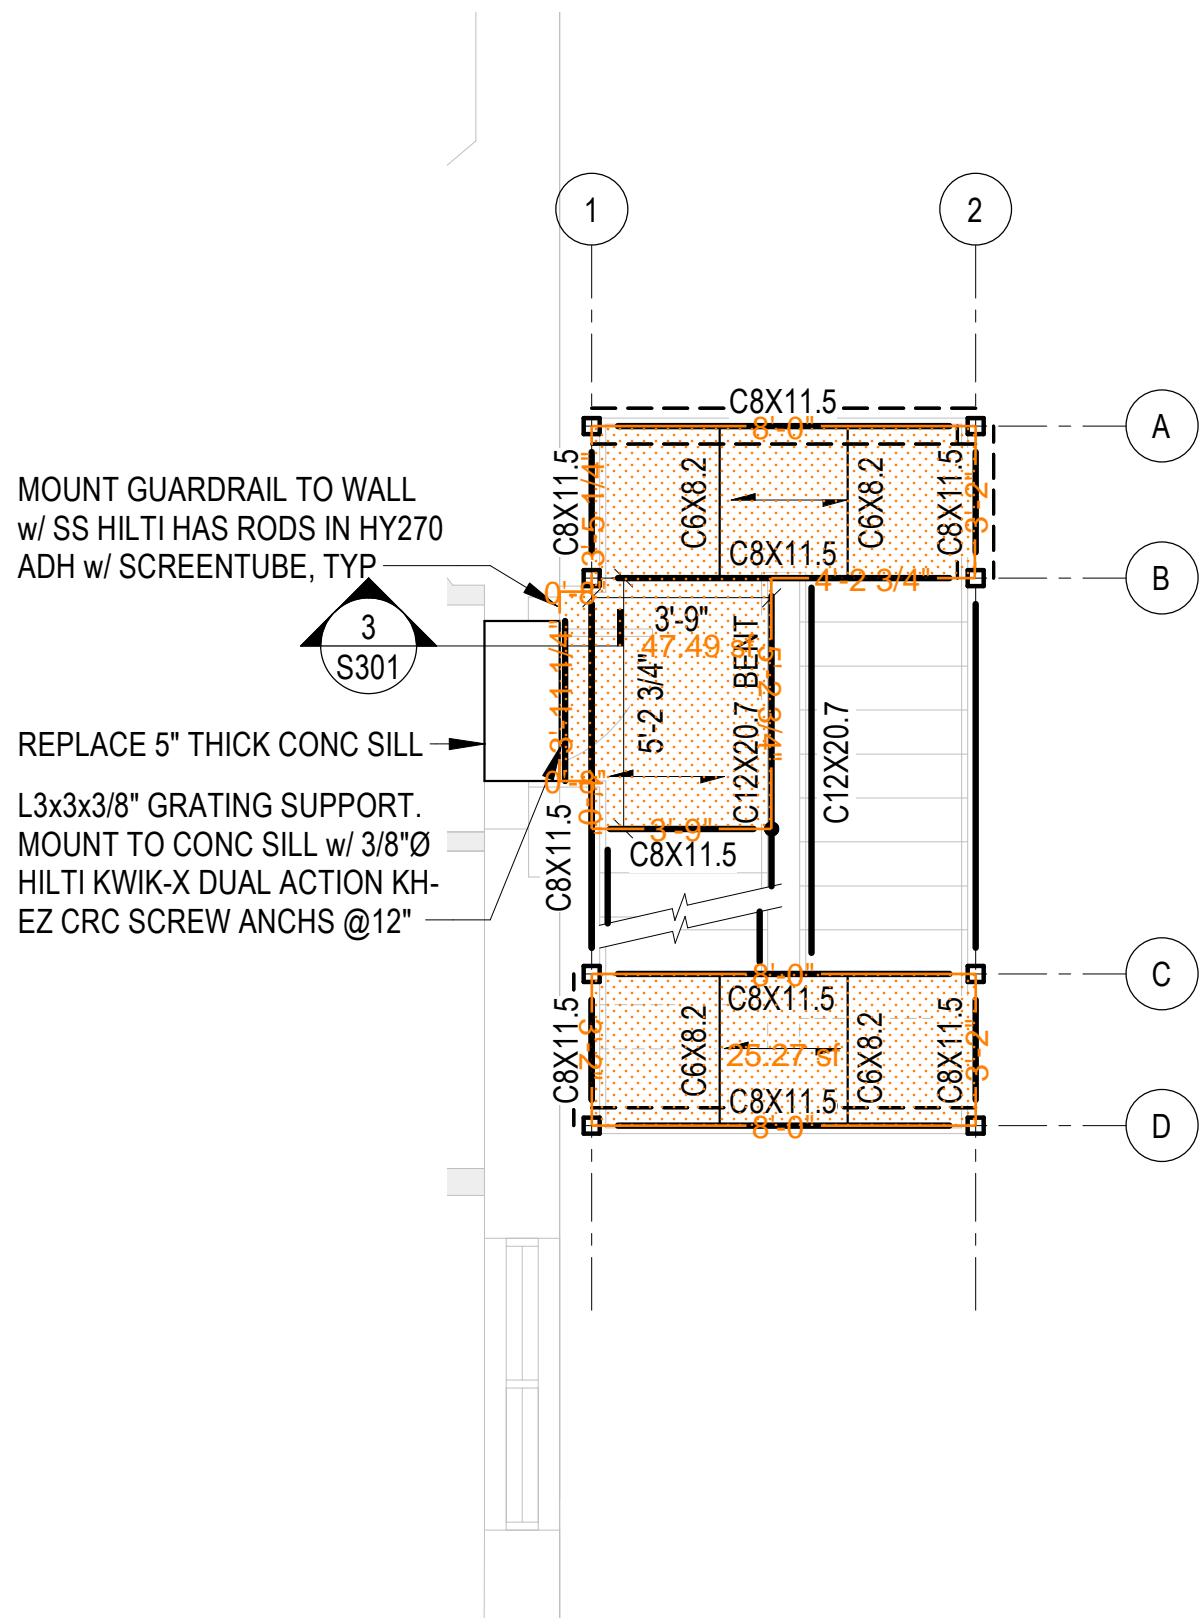

4 PARTIAL SECOND FLOOR PLAN
S100
SCALE AT FULL SIZE 1/4" = 1'-0"

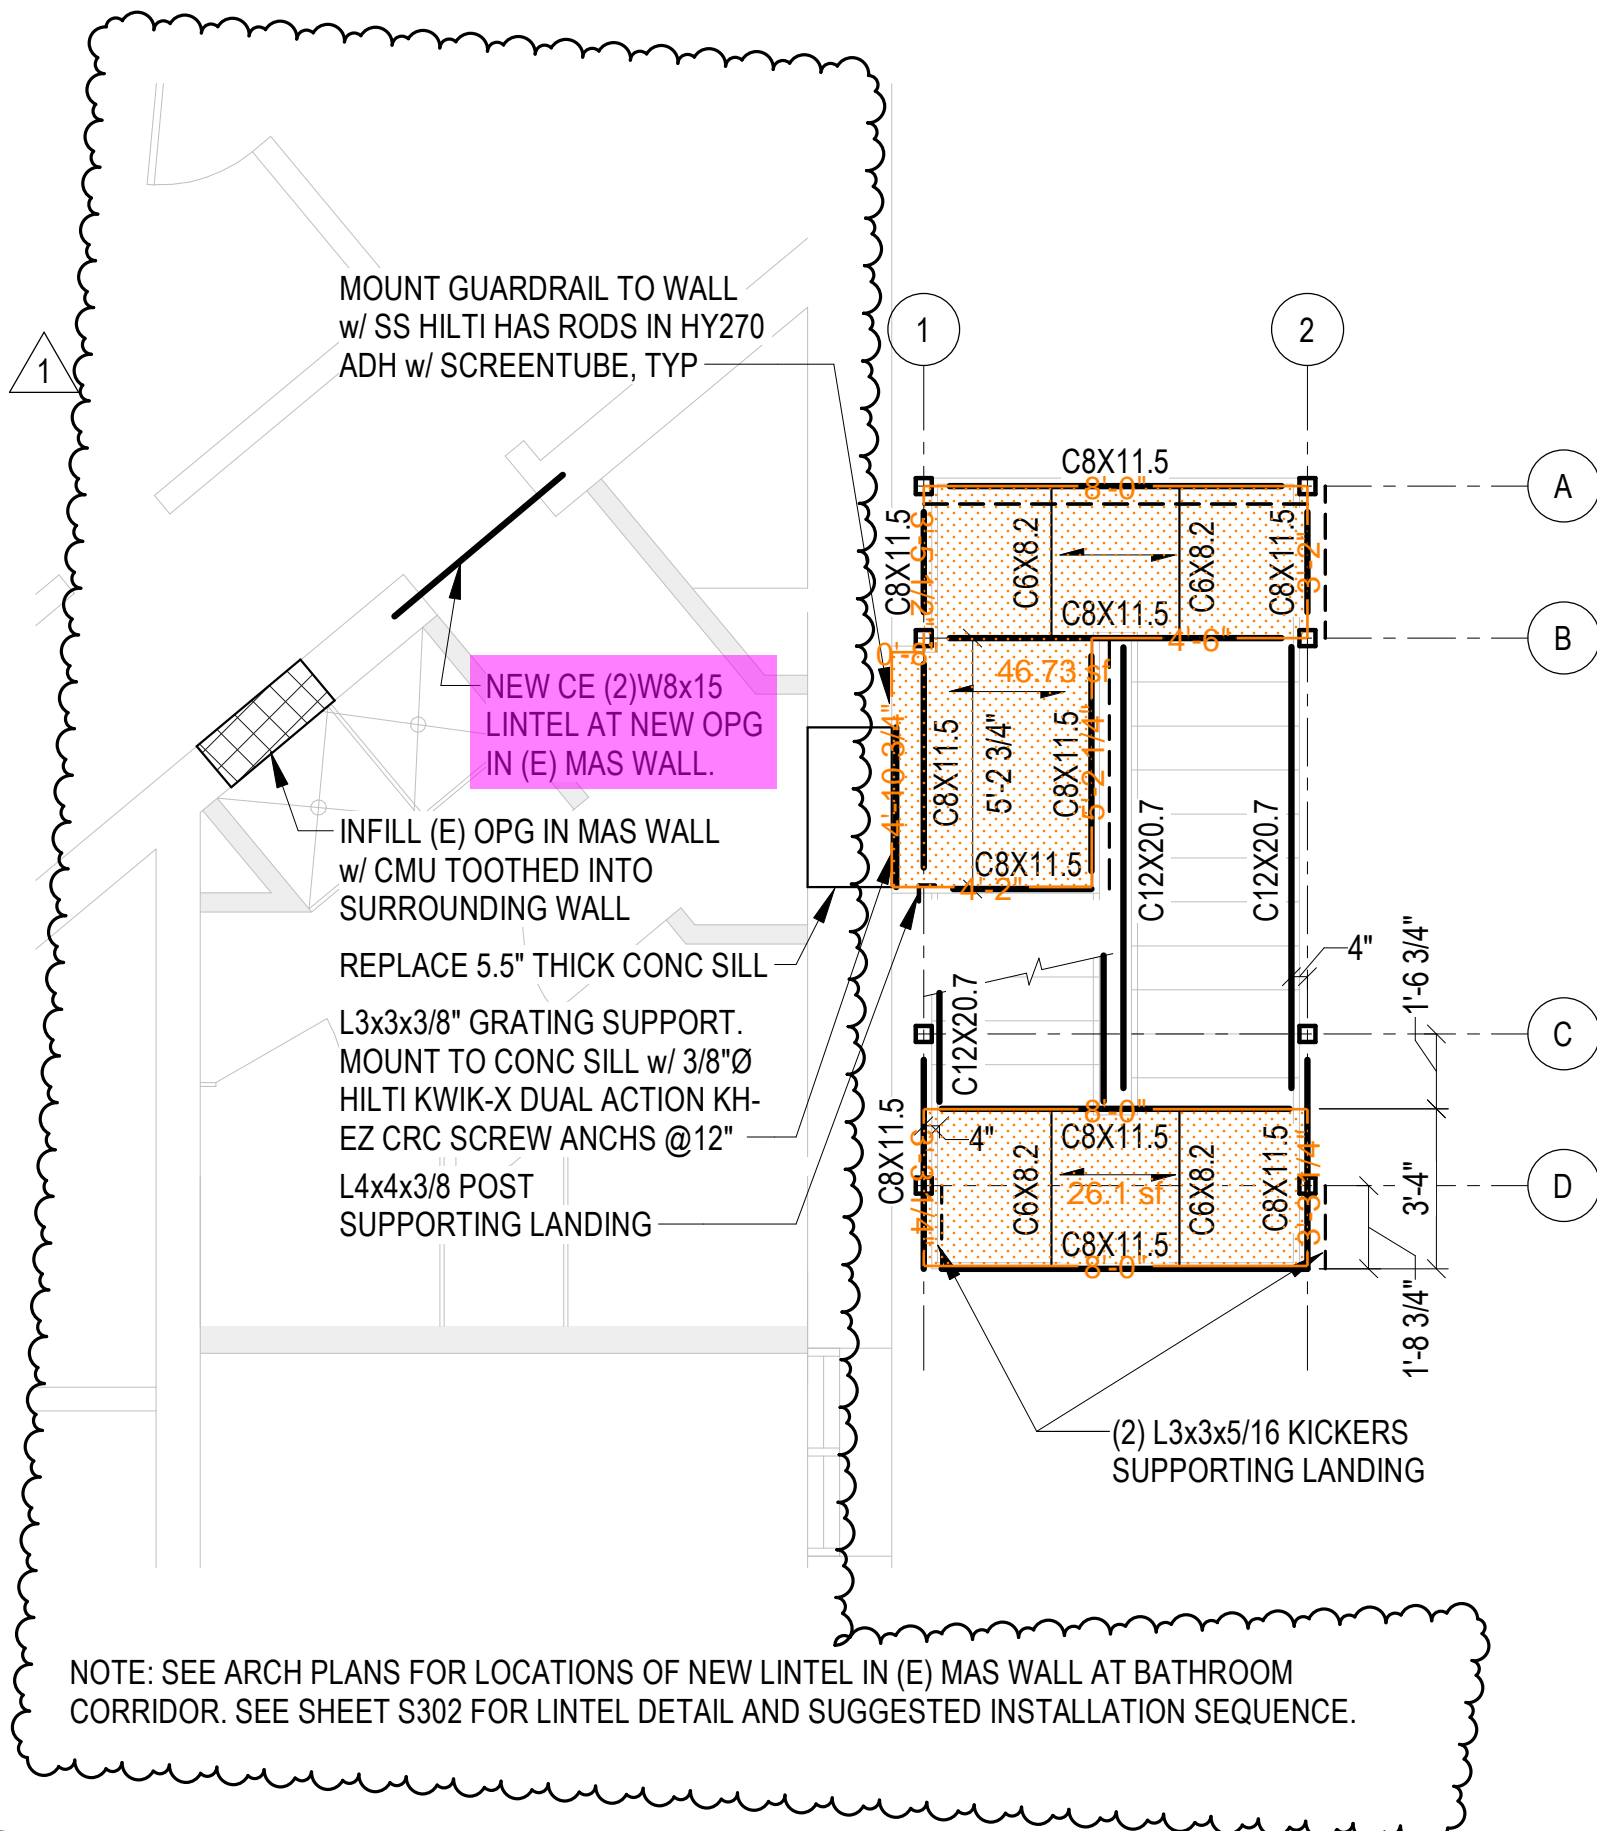

5 PARTIAL THIRD FLOOR PLAN
S100
SCALE AT FULL SIZE 1/4" = 1'-0"

- FRAMING PLAN NOTES:
- REFERENCE ARCHITECTURAL DRAWINGS FOR EDGE OF SLAB DIMENSIONS.
 - REFERENCE SHEET S300-S301 FOR TYPICAL DETAILS OF CONSTRUCTION NOT SHOWN ON PLAN.
 - REFERENCE SHEET S201 FOR BRACED FRAME ELEVATIONS.
 - BEAMS TO BE SPACED EQUALLY BETWEEN COLUMN LINES UNLESS NOTED OTHERWISE.
 - TOP OF STRUCTURAL STEEL ELEVATIONS SHALL BE LOCATED 1" ABOVE FLOOR ELEVATION UNLESS NOTED OTHERWISE.
 - 4" SOG INDICATES A 4" THICK NWC SLAB ON GRADE REINFORCED WITH 6x6 W2.0xW2.0 WWF PLACED ON A 6" LAYER OF COMPACTED #57 STONE. SEE CAST-IN-PLACE CONCRETE PROPERTIES SCHEDULE ON S003 AND TYPICAL CONCRETE DETAILS ON S300 FOR INFORMATION NOT SHOWN ON PLAN.

Signature and Date

Constantine G. Doukakis, P.E.
Penna. Professional Engineer
No. 35208-E

FORD3

ARCHITECTS, LLC

243 N Union St., Suite 117 | Lancaster, PA 17601
609.924.0043 office | office@ford3.com

ZETA PSI BUILDING FIRE ESCAPE
3337 WALNUT STREET, UNIVERSITY OF PENNSYLVANIA
PHILADELPHIA, PA 19104

Drawn By AMG
Checked By CGD
Date AS NOTED BELOW
Revisions 02/14/2024 DESIGN DEVELOPMENT SET 04/30/2024 CONSTRUCTION DOCUMENT SET 05/10/2024 ADDENDUM #1
Project No 2134
Drawing Title FLOOR PLANS
File Name
S100

ALL DIMENSIONS MUST BE VERIFIED BY CONTRACTOR AND ENGINEER MUST BE NOTIFIED OF ANY DISCREPANCIES BEFORE PROCEEDING WITH THE WORK.
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